






WINDOW TYPES

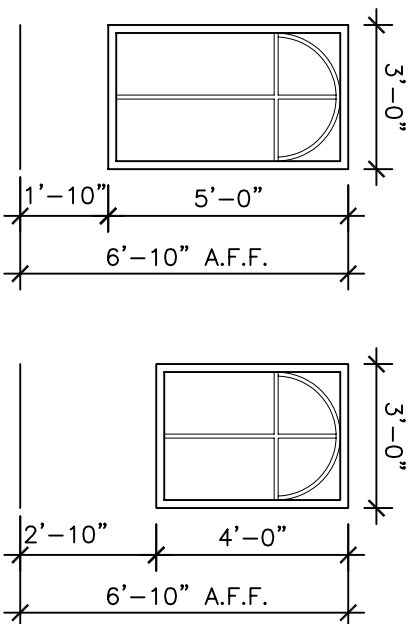

WINDOW SCHEDULE					REMARKS
TYPE	FRAME	WIDTH	HEIGHT		
A	ALUM	3'-0"	5'-0"		FIXED UNITS
B	ALUM	3'-0"	4'-0"		FIXED UNITS

LEGEND



- ▶ REMOTE HEAD
- EXIT SIGN
- EMERGENCY LIGHT
- FIRE EXTINGUISHER

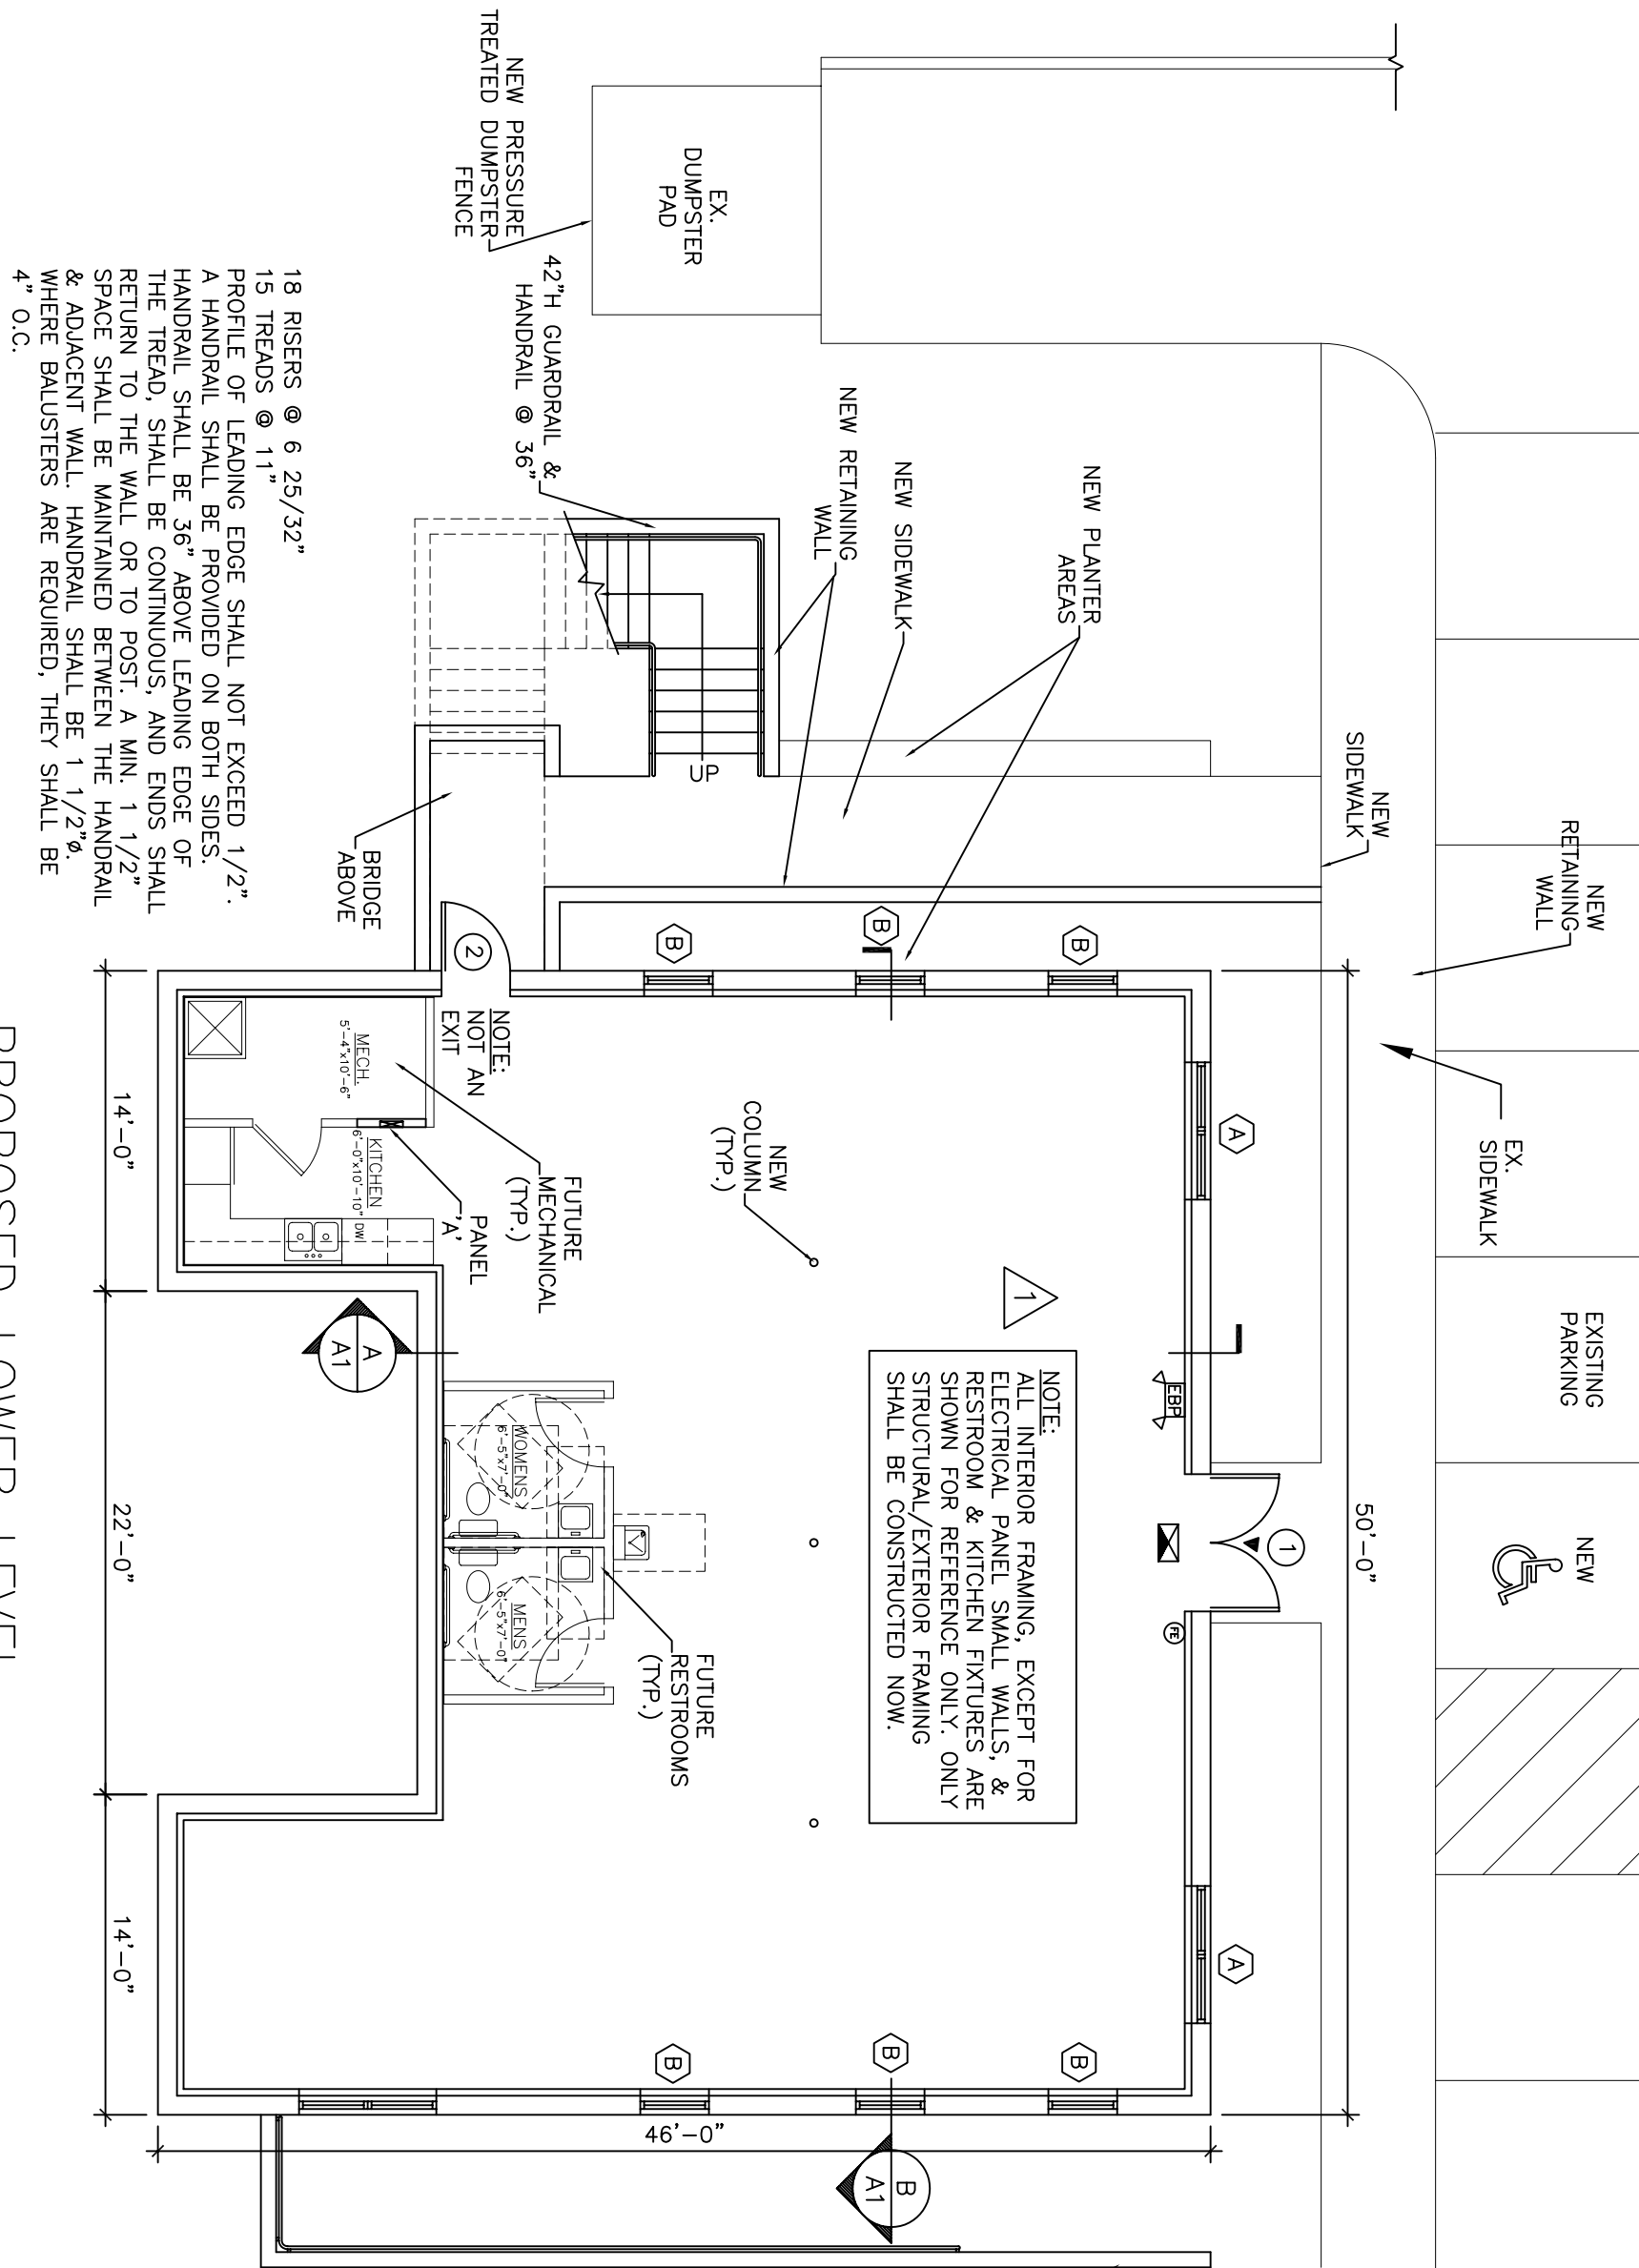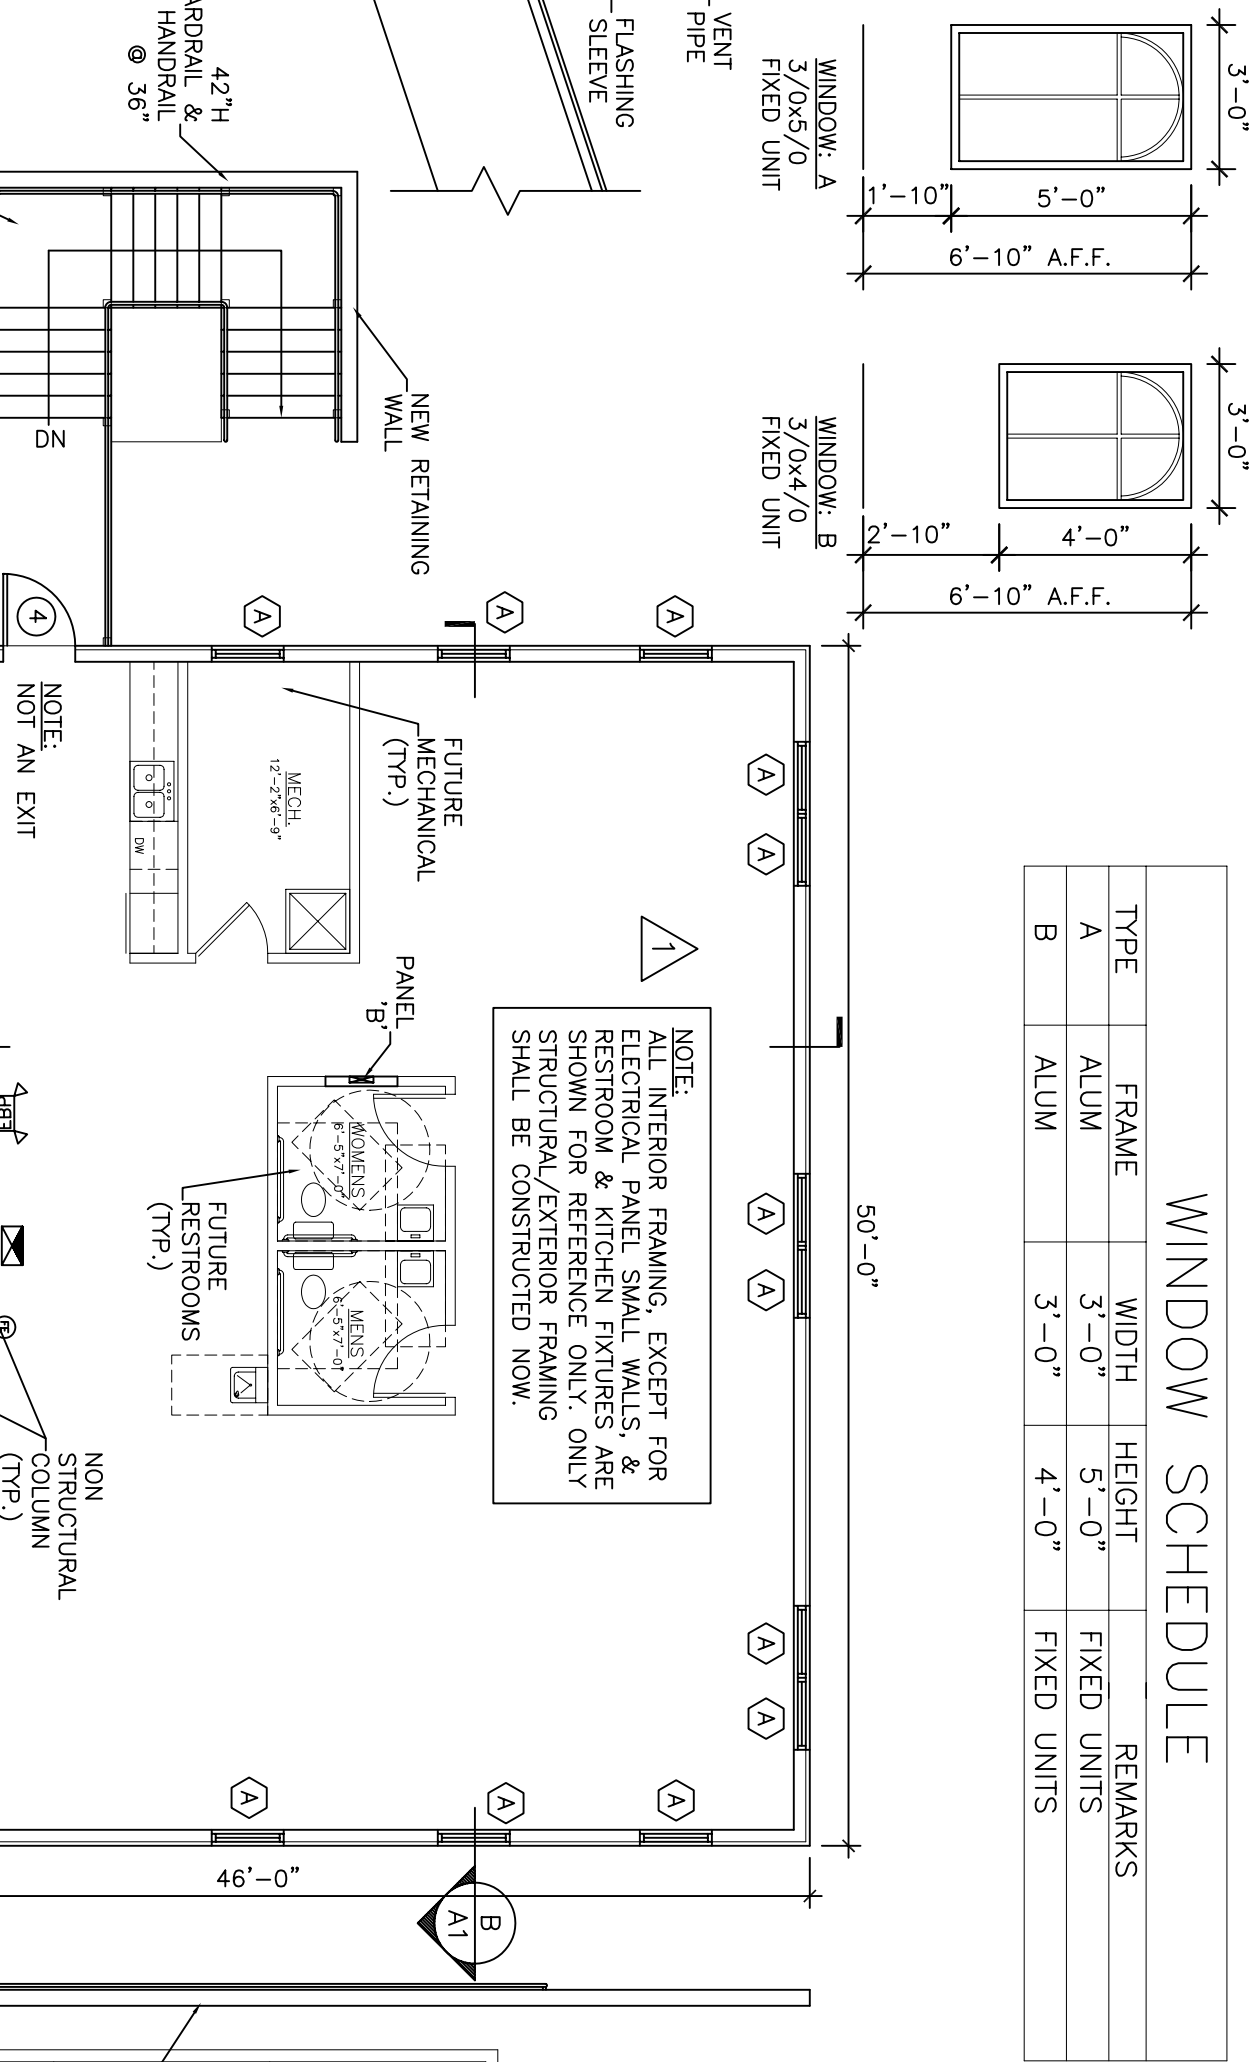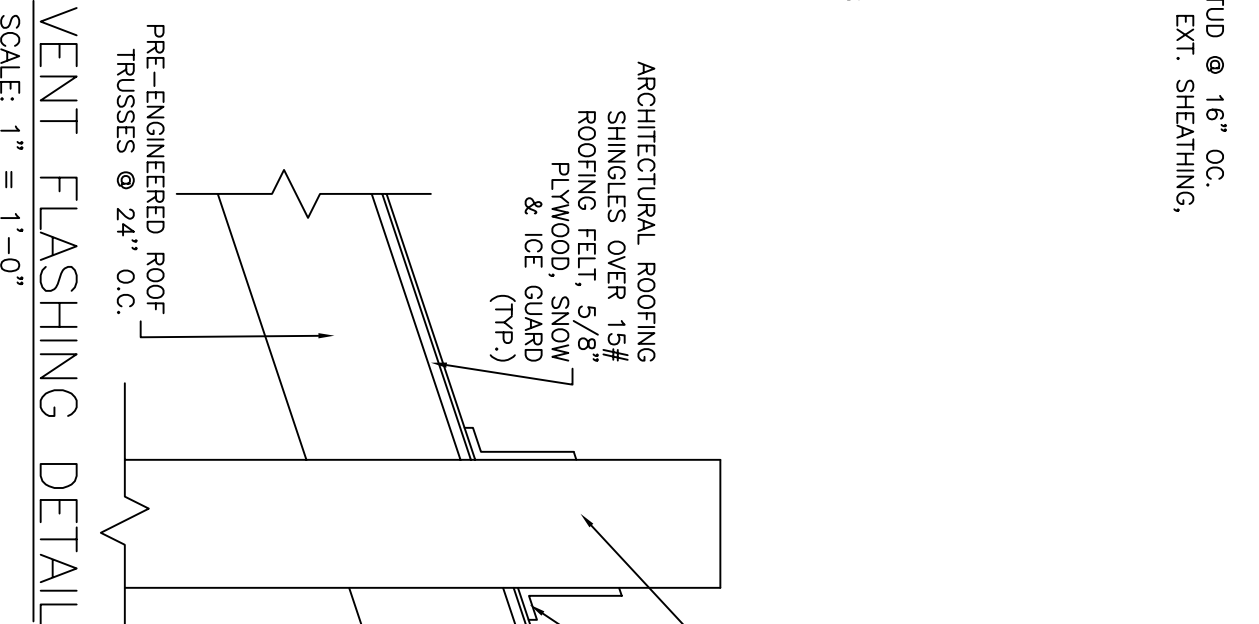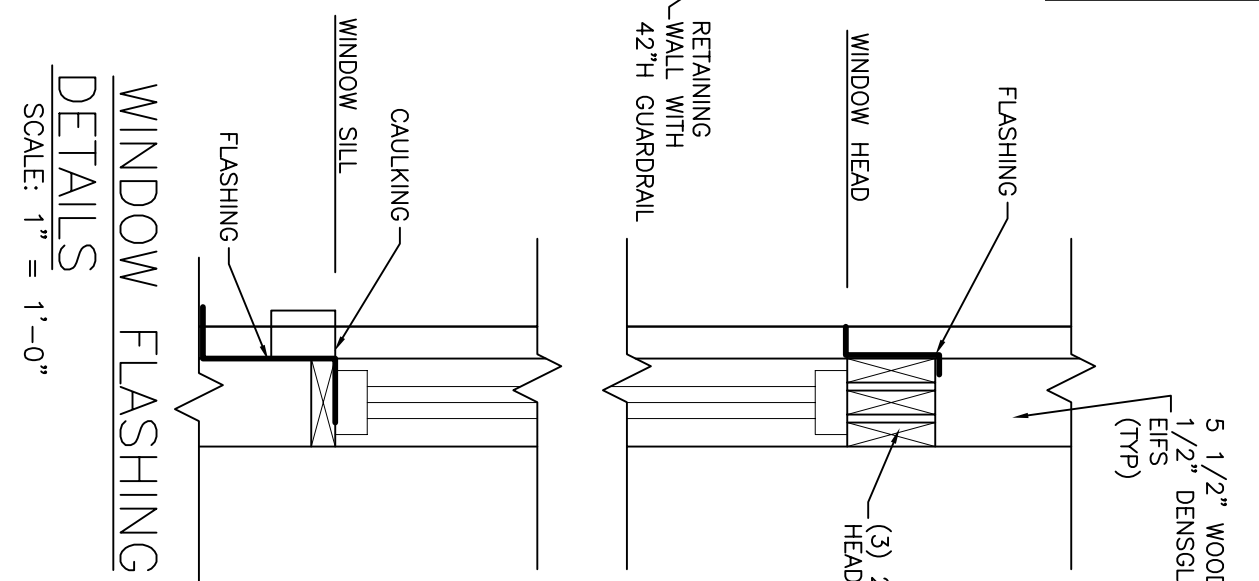

BUILDING

DOOR HEADER FLASHING DETAIL

SCALE: 1" = 1'-0"

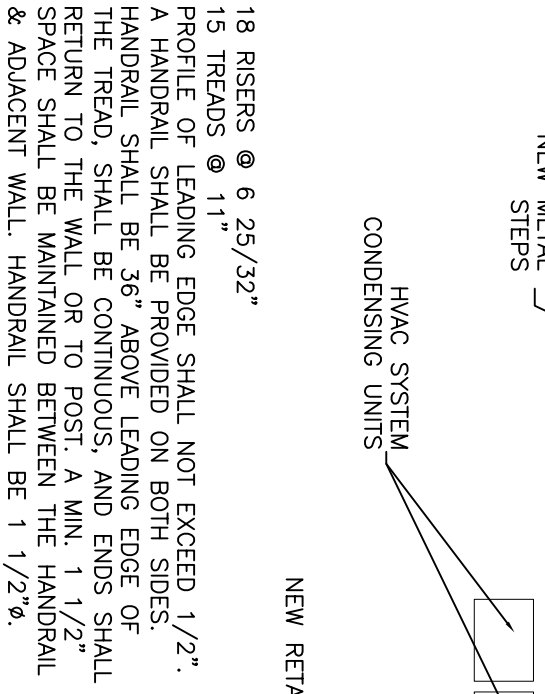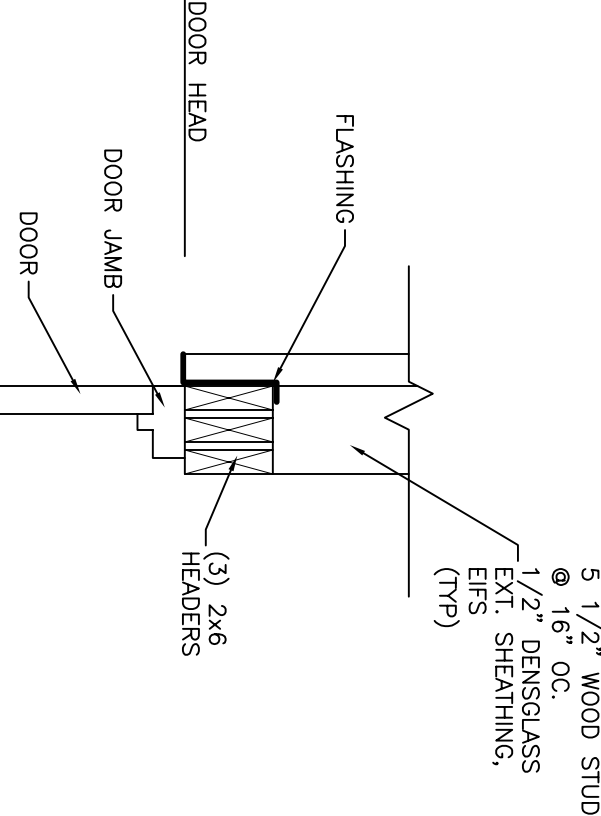

PROPOSED UPPER LEVEL

SCALE: 1/8" = 1'-0"




DOOR SCHEDULE										
#	TYPE	MATL	WIDTH	HEIGHT	THICK	FINISH	HOW GRP	FRAME FINISH	LITE	REMARKS
1	A	ALUM/GLASS	(2)3/0	6/8	1	3/4"	ALUM.	ALUM. STD	FULL	TEMPERED GLASS
2	B	INSULATED METAL	3/0	6/8	1	3/4"	PANT	1		
3	A	ALUM/GLASS	(2)3/0	6/8	1	3/4"	ALUM.	ALUM. STD	FULL	TEMPERED GLASS
4	B	INSULATED METAL	3/0	6/8	1	3/4"	PANT	1		

HARDWARE TYPES

- HARDWARE SET #1
- 3 EA. HINGES
- 1 EA. THRESHOLD
- 1 EA. PUSH/PULL
- 1 EA. CLOSERS
- 1 EA. THUMBTURN LOCKSET

- DOOR TYPE-A
- (2)3/0x6/8x1 3/4
- ALUMINUM
- FULL LITE
- TEMPERED GLASS

- DOOR TYPE-B
- (2)3/0x6/8x1 3/4
- ALUMINUM
- FULL LITE
- TEMPERED GLASS

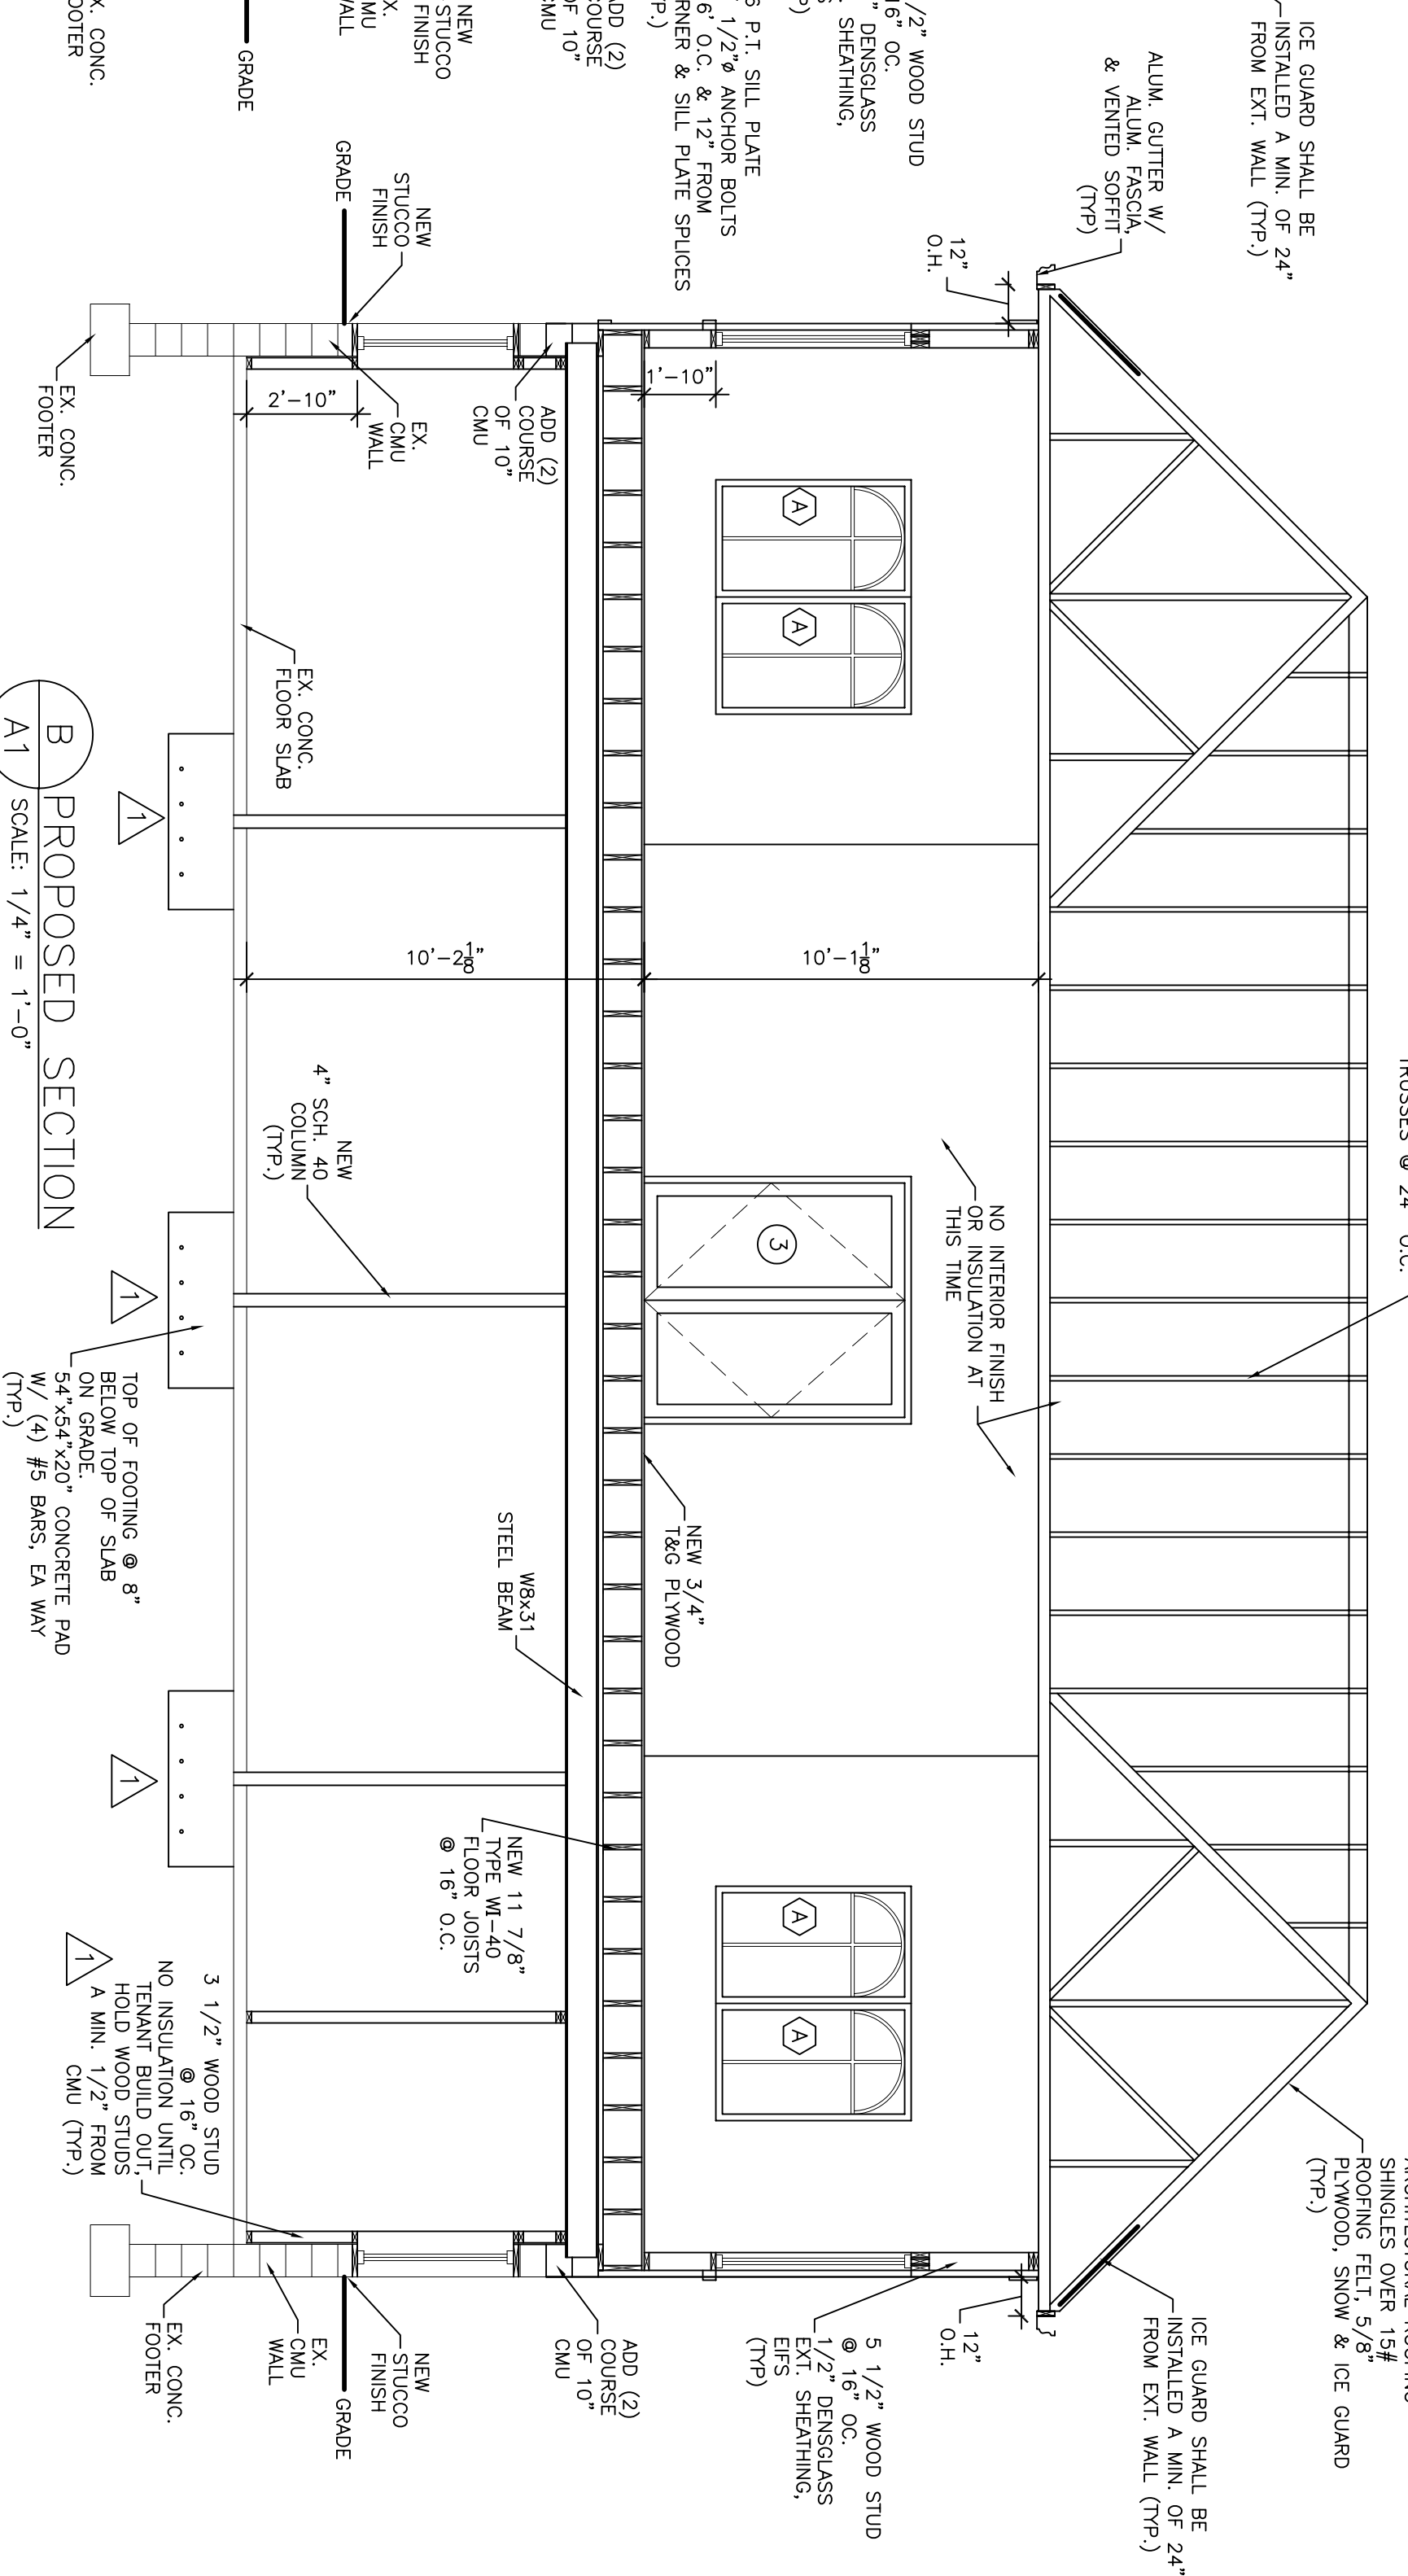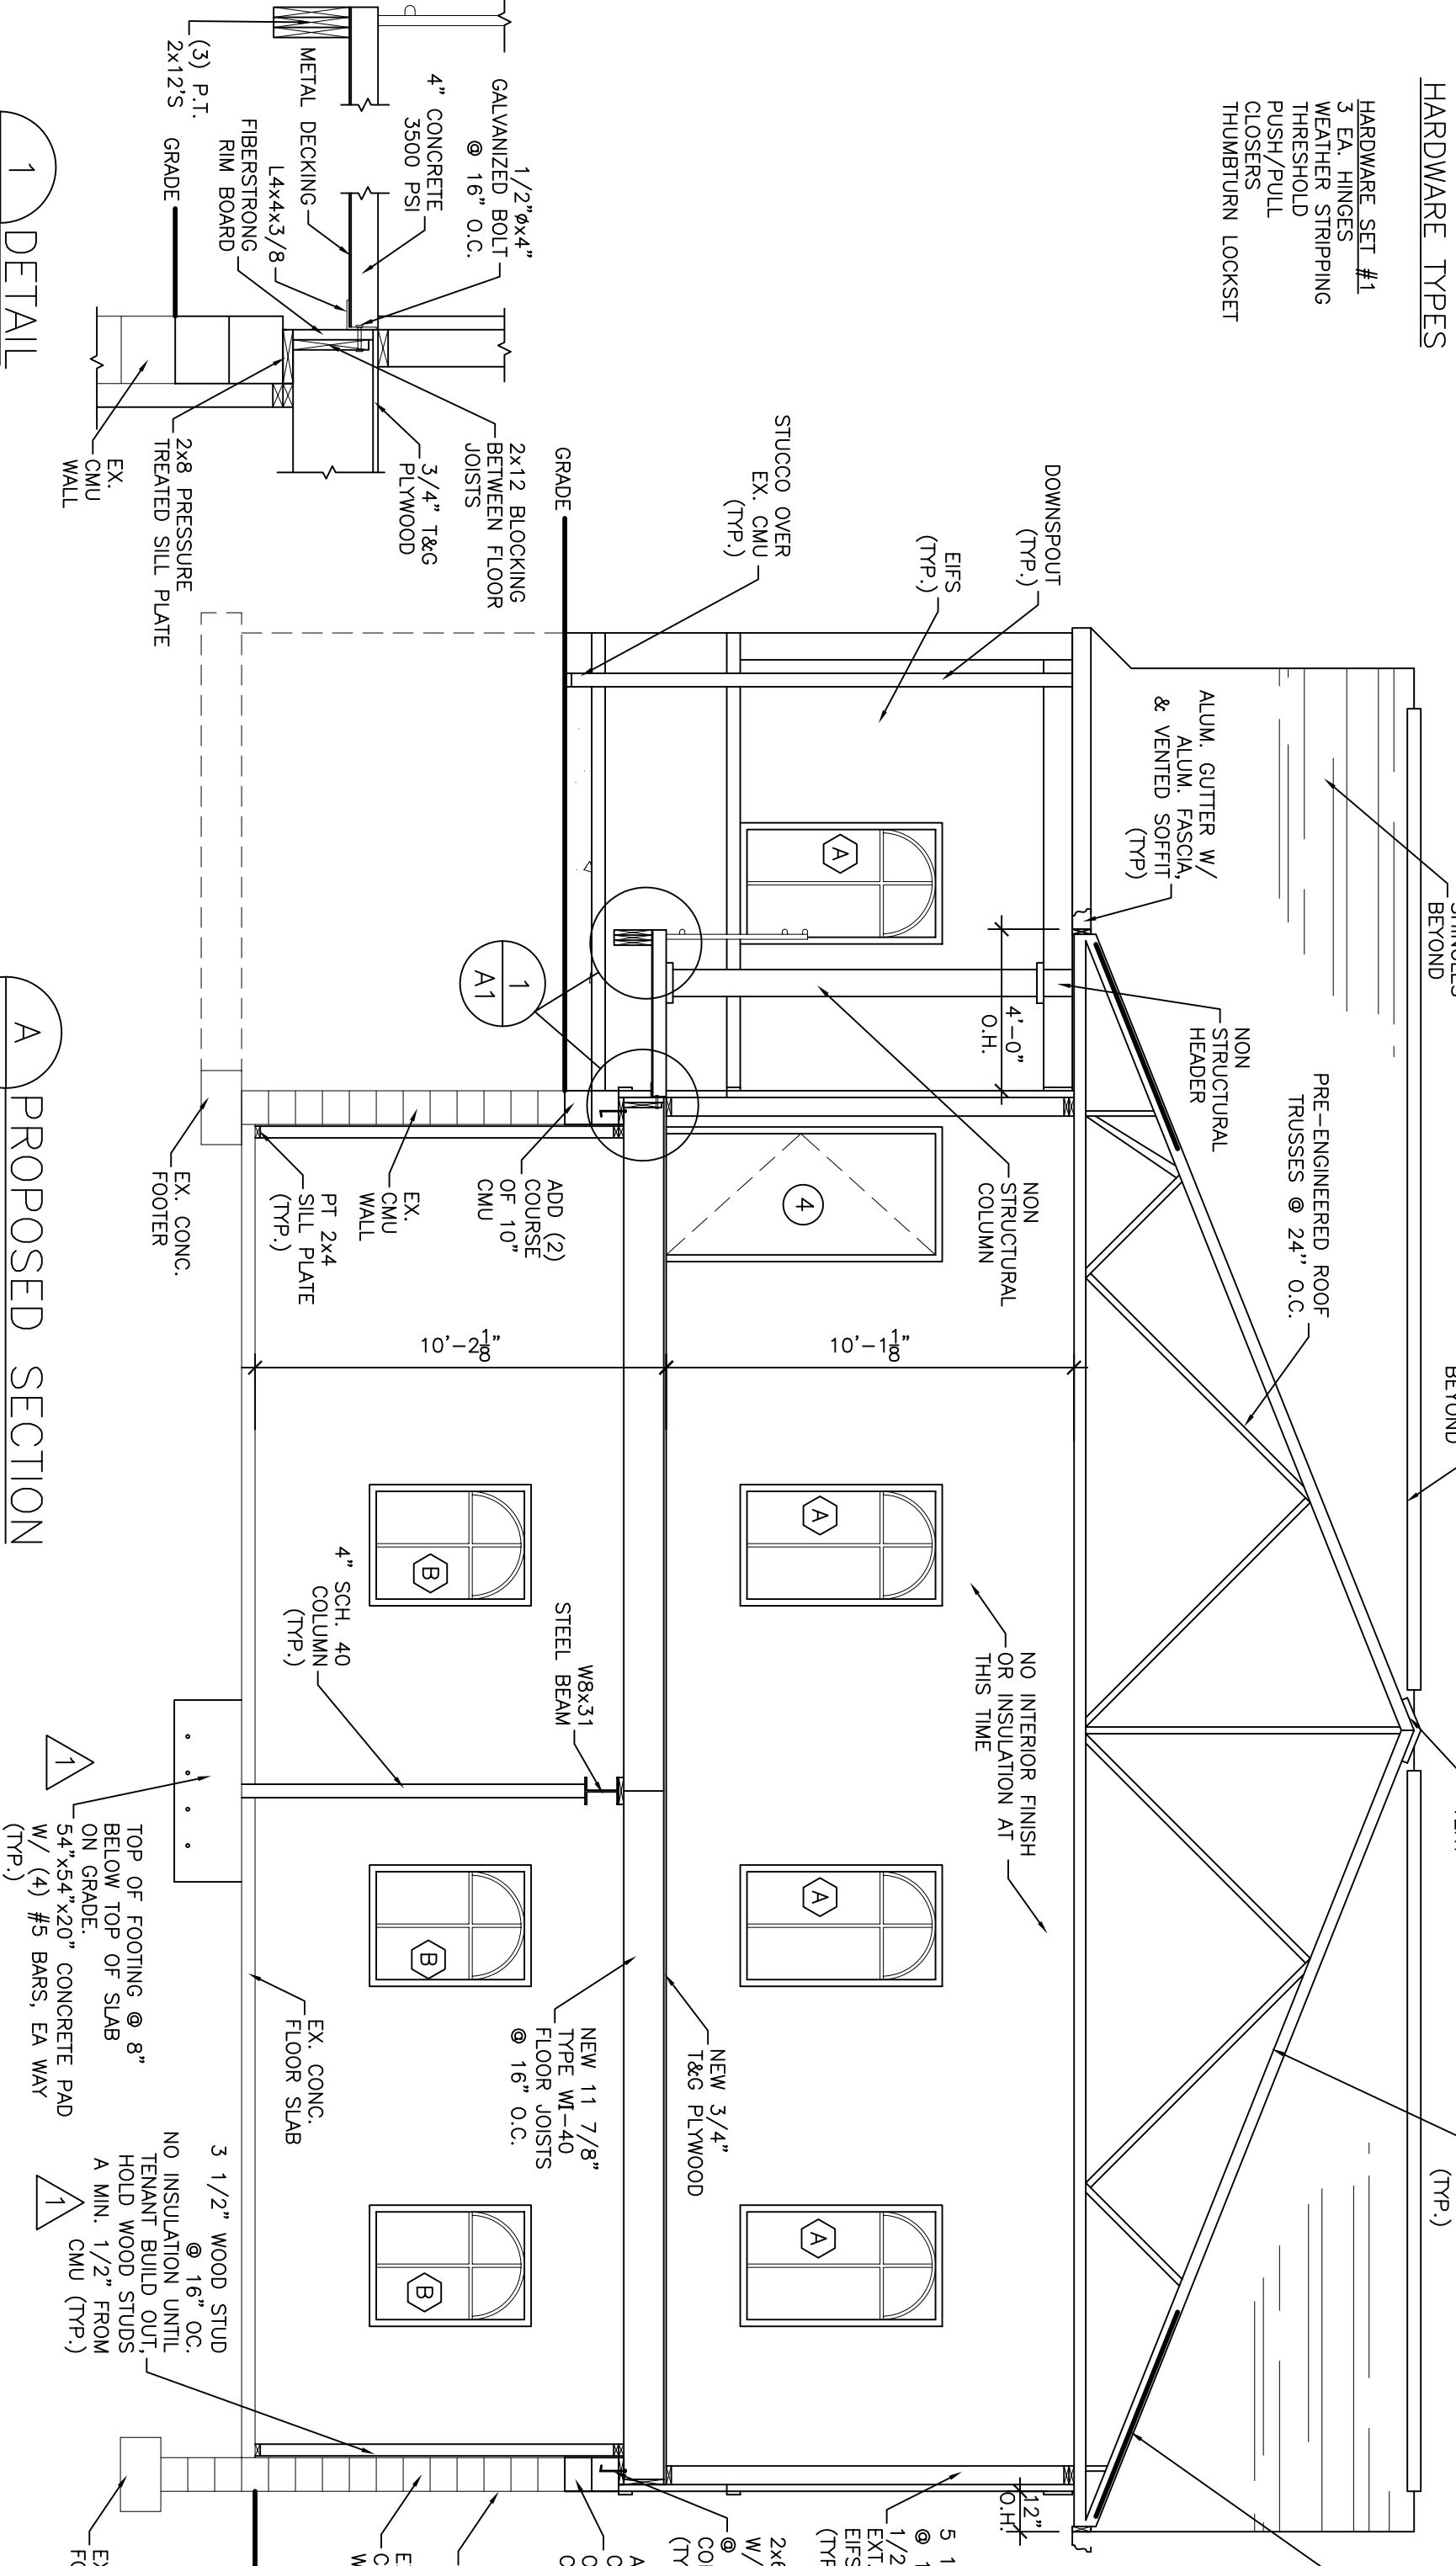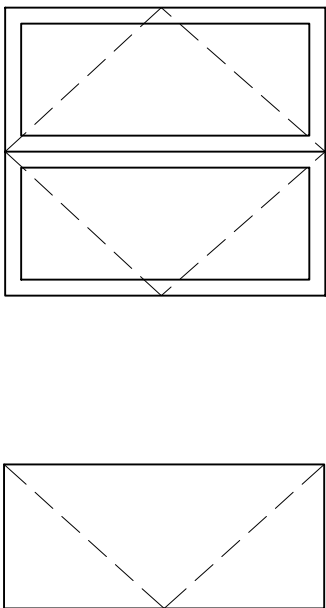

1 DETAIL

SCALE: 1/2" = 1'-0"

A PROPOSED SECTION

SCALE: 1/4" = 1'-0"

B PROPOSED SECTION

SCALE: 1/4" = 1'-0"

PROJECT

RENOVATIONS TO:
102 E. CLINTON AVE.
STATE COLLEGE, PA 16801

REVISION DATE

03/29/07 RSP

SHEET TITLE

PROPOSED FLOOR PLANS, SECTIONS & SCHEDULES

DATE

02/06/07

SCALE

AS NOTED

DRAWN BY:

AAO/RSP/LED

CHECKED BY

AAD

SHEET NO.

A1

PROJECT #

0693

ALBERT A. DROBKA ARCHITECT
P.O. BOX 256
1352 S. ATHERTON ST.
STATE COLLEGE, PA.
(814) 238-0710